
BOILER ROOM DEMOLITION NOTES:

- PRIOR TO ANY EXECUTION OF WORK, CONTRACTOR SHALL MEET WITH OWNER, AND ENGINEER AND DISCUSS SCOPE OF DEMOLITION.
- PRIOR TO ANY DEMOLITION, ISOLATION OF SYSTEMS OR SHUTDOWNS, CONTRACTOR SHALL FIELD TRACE AND VERIFY SYSTEM TO BE WORKED ON AND NOTIFY FACILITIES ENGINEERING/MAINTENANCE OF WORK TO BE PERFORMED SO AS TO AVOID ANY DETRIMENTAL SHUTDOWN OF SYSTEMS.
- 3. CONTRACTOR SHALL BE RESPONSIBLE FOR MAINTAINING SAFETY BY CUTTING AND MAKING SAFE ANY DEMOLITION WORK.
- 4. CONTRACTOR SHALL NOTIFY OWNER AND ENGINEER OF ANY SITUATIONS THAT DIFFER OR ENHANCE THE SCOPE OF WORK FROM THAT DESCRIBED IN THE DOCUMENTS.
- 5. CONTRACTOR SHALL COORDINATE PHASING OF THE PROJECT WITH THE OWNER FOR SHUTDOWNS, DEMOLITION AND TEMPORARY OPERATION.
- 6. UPON REMOVAL, ALL EQUIPMENT SHALL BE DISPOSED OF EXCEPT MAJOR ITEMS, WHICH THE CONTRACTOR SHALL INVENTORY AND SUBMIT A LIST TO THE OWNER. ALL ITEMS NOT RETAINED BY OWNER SHALL BECOME PROPERTY OF THE CONTRACTOR AND SHALL BE DISPOSED OF PROPERLY.
- 7. EXISTING BREECHING AND ALL ASSOCIATED SUPPORTS, INSULATION, FANS AND ANY OTHER APPURTENANCES TO BE REMOVED. 8. ALL EXISTING PIPING WITHIN BOILER ROOM AND ALL ASSOCIATED SUPPORTS, VALVES, CONTROLS AND ANY OTHER APPURTENANCES TO BE REMOVED AND CUT AND CAP. CUT AND CAP ALL GAS PIPING AT BOILER TO THE EXTENT SHOWN.
- 9. EXISTING BOILERS AND ALL ASSOCIATED BURNERS, SUPPORTS, INSULATION, VALVES, PIPING, CONTROLS, PUMPS, EXPANSION TANKS, CHEMICAL SHOT FEEDERS AND ANY OTHER BOILER APPURTENANCES TO BE REMOVED.
- 10. RECOMMENDED PATH FOR CONTRACTOR TO REMOVE DEMOLISHED EQUIPMENT AND TO RIG IN NEW EQUIPMENT. CONTRACTOR TO REMOVE DOOR, DOOR FRAME, AND CMU TO THE LIMITS NECESSARY FOR PASSAGE OF NEW EQUIPMENT. PROVIDE TEMPORARY SHORING AS REQUIRED TO SUPPORT NEW OPENING. AFTER RIGGING IS COMPLETE REPAIR OPENING AND INSTALL EXISTING DOOR.

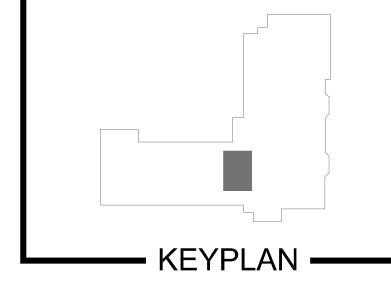


New Brunswick, NJ


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DATE CHK DESCRIPTION 10/3/2011 ADDENDUM #1

PROJECT

20110321

09-02-11

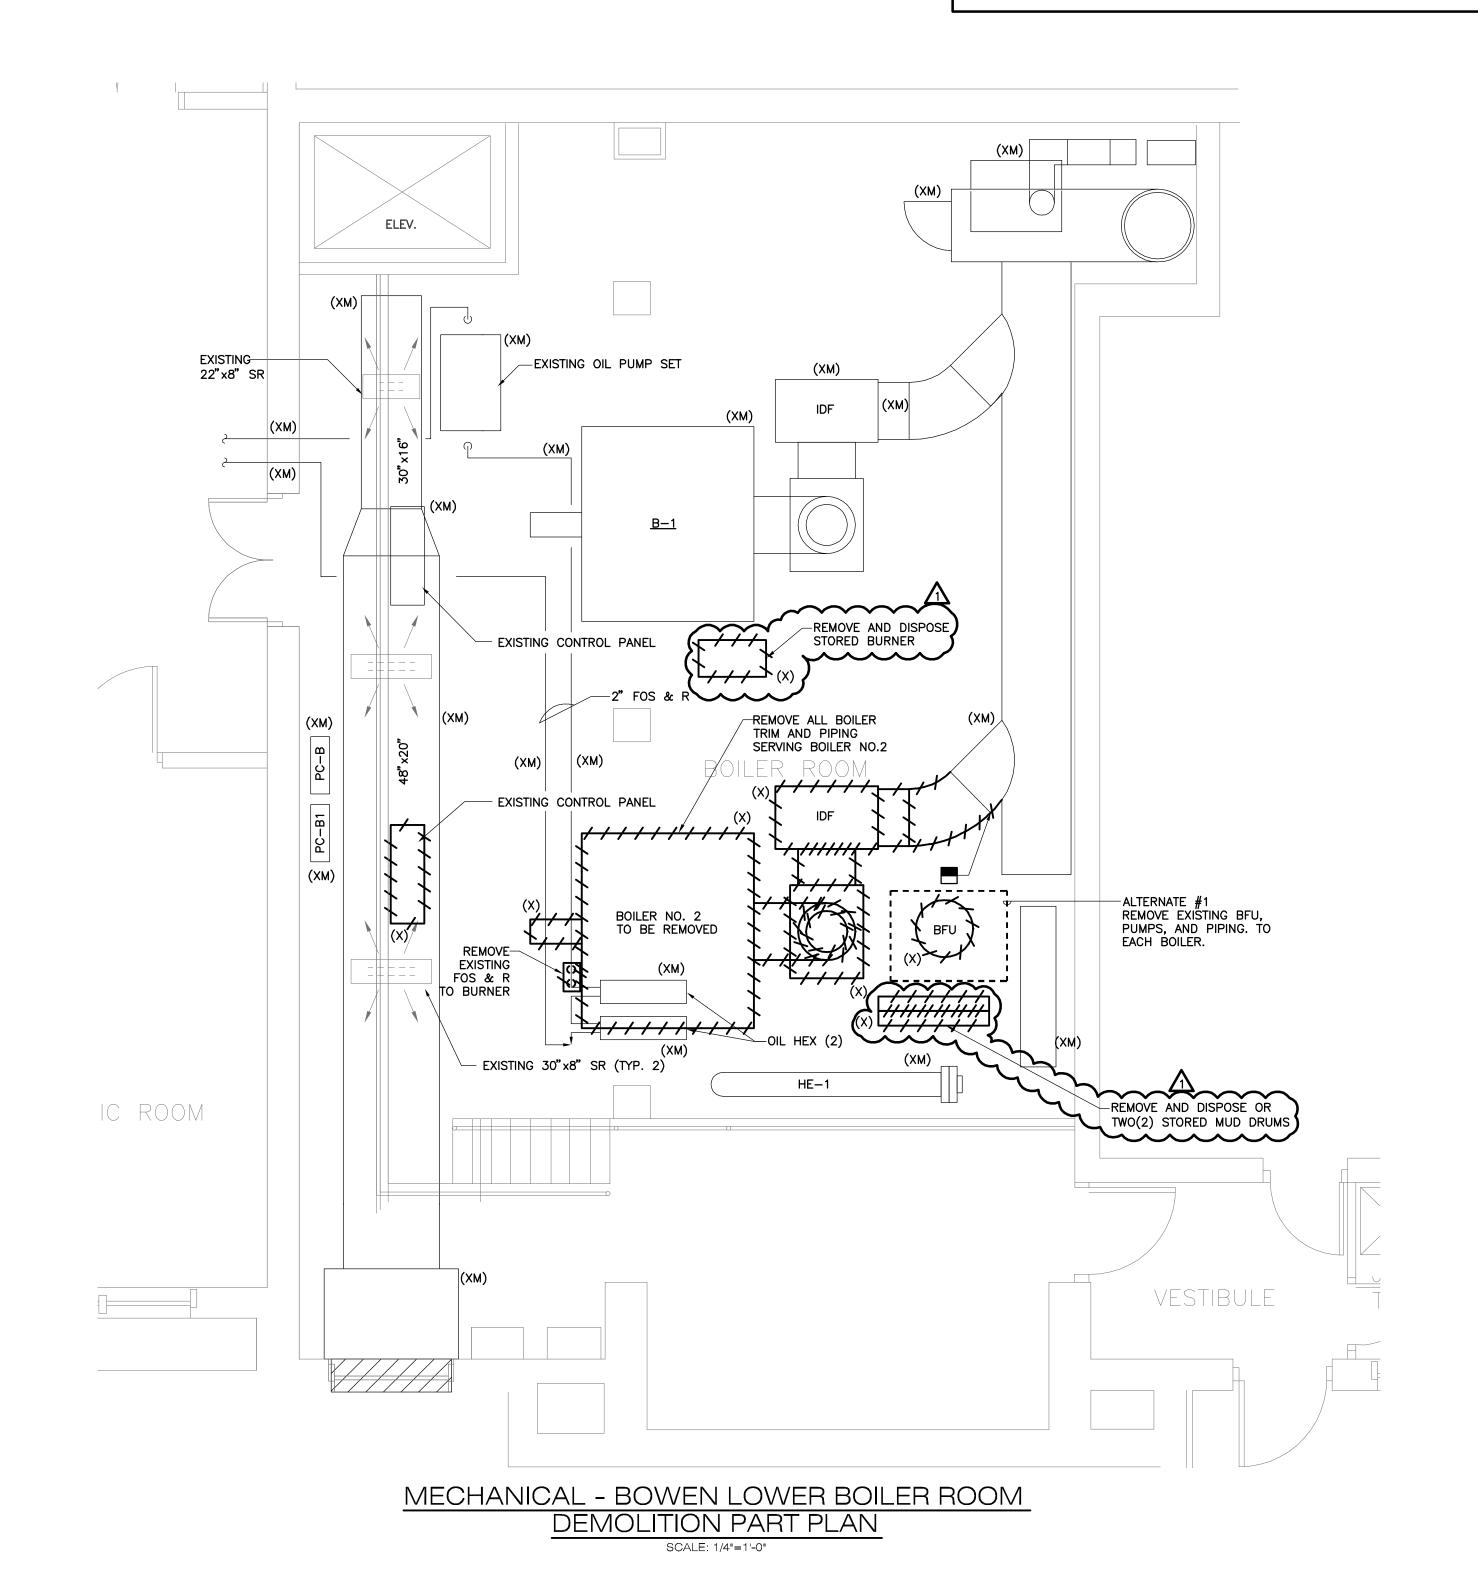NEWTON PUBLIC SCHOOLS BOWEN/COUNTRYSIDE **ELEMENTARY SCHOOL BOILER RENOVATION** NEWTON, MA 02459

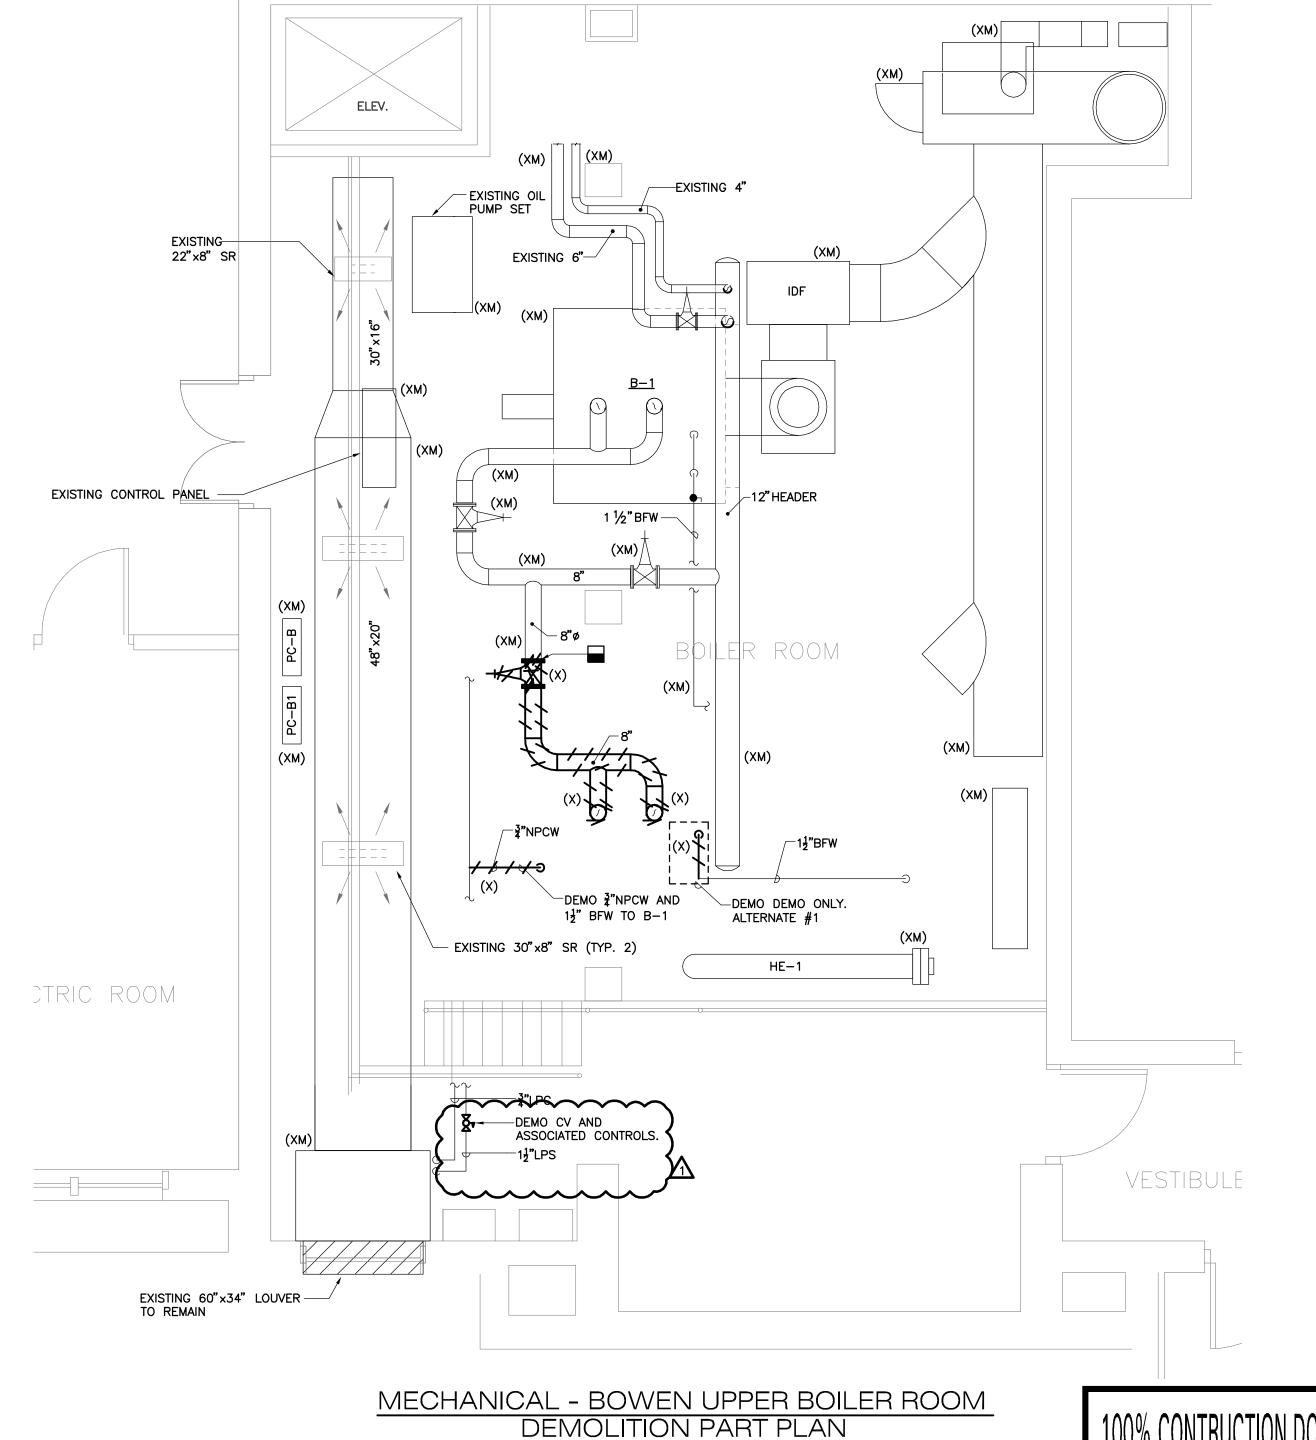DRAWING

KVM

CHECKED BY WW

SCALE-


AS NOTED

MECHANICAL BOWEN BOILER ROOM DEMOLITION PART PLANS



1/4" = 1' - 0" 0 4' 8' MD2.00

09-02-2011

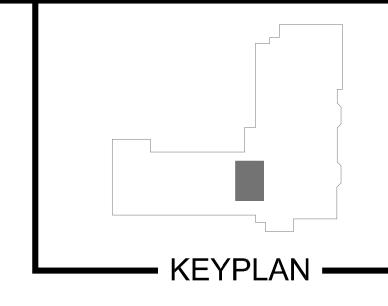

New Brunswick, NJ

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NEWTON PUBLIC SCHOOLS

BOWEN/COUNTRYSIDE **ELEMENTARY SCHOOL BOILER RENOVATION** NEWTON, MA 02459

DRAWING

DRAWN BY KVM

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WW

SCALE-AS NOTED

MECHANICAL **BOILER ROOM**

NEW WORK PART PLANS

EXISTING -〔24"x24"/ 22"x8" SR EXISTING 6"-EXISTING CONTROL PANEL--12"HEADER NEW BOILER--NEW CONTROL PANEL (XM) -NEW BREECHING SPILL SWITCH EXISTING 30"x8" SR (TYP. 2) -HE-1 CTRIC ROOM NEW CV AND CONTROLS SEE NOTE 1. ____1 ½"LPS VESTIBULE H&V-1

> MECHANICAL - BOWEN UPPER BOILER ROOM NEW WORK PART PLAN

NOTES
1. PROVIDE NEW STEAM CONTROL VALVE AND CONTROLS TO MODULATE TO MAINTAIN 60 DEGREES(F) LAT FROM EXISTING

EXISTING 60"x34" LOUVER -





09-02-2011

EXISTING — 22"x8" SR

IC ROOM

IDF

REFER TO M7.01 FOR NEW BOILER FEED PIPING AND ALL BLOWDOWN PIPING

BOILER ROOM

HE-1

ALTERNATE #1-PROVIDE NEW BFU, NEW CONNECTING PIPING TO EACH BOILER, AND NEW CONCRETE

MECHANICAL - BOWEN LOWER BOILER ROOM

NEW WORK PART PLAN

SCALE: 1/4"=1'-0"

EQUIPMENT PAD(SAME AS BOILER PAD).

BFU 1

L-----

NEW 6" HIGH 3,000 PSI
CONCRETE PAD 6" GREATER IN
WIDTH & LENGTH THEN

BOILER/BURNER ASSEMBLY WITH

REINFORCEMENT AND ½"

DOWELING @ 18" CENTERS BOTH

WAYS DOWELS TO BE NO MORE

THAN 3" FROM EDGES OF PAD

VESTIBULE

CHAMPHERED EDGES. PROVIDE

HEAVY GAUGE WIRE

<u>B-1</u>

NEW 1" FOS & R ON TO BURNER


- EXISTING 30"x8" SR (TYP. 2)

-REPLACE H&V-1 FILTERS

EXISTING 60"x34" LOUVER ----

H&V-1

BOILER NO. 2

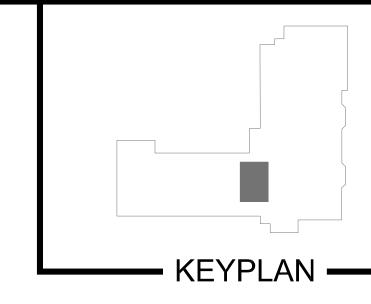

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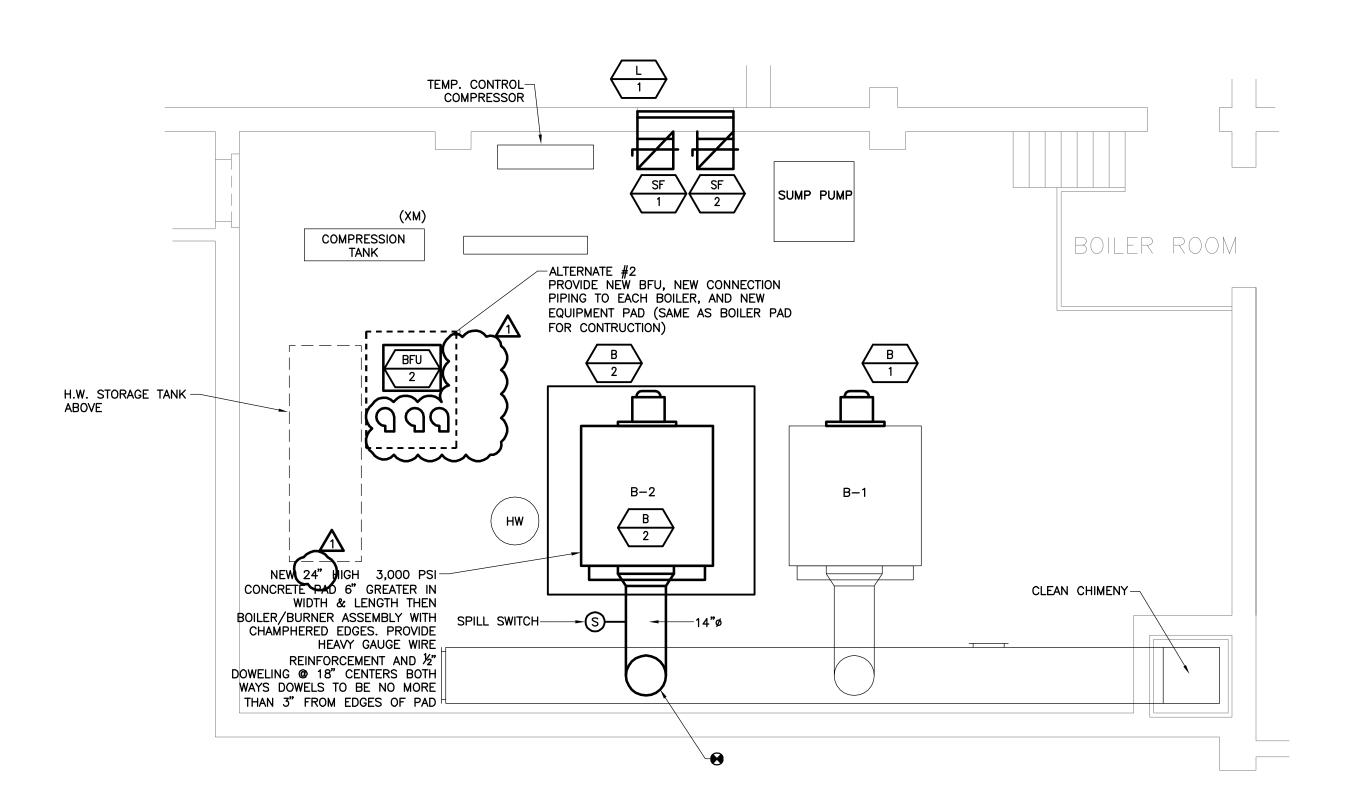
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TEMP. CONTROL-COMPRESSOR PROVIDE NEW SPOOL PIECE TO REPLACE REMOVED VAPOR CONVERTOR-TURBINE VALVE COMPRESSION BOILER ROOM FLOOR DRAIN-TANK (TYPICAL) -ALTERNATE #2 GOES TO-STORAGE H.W. STORAGE TANK -—¾"LPC REFER TO M7.01 FOR NEW BOILER FEED B-2 PIPING AND ALL BLOWDOWN PIPING. -REFER TO M7.01 FOR NEW BOILER FEED PIPING AND PROVIDE UP TO 3 NEW— WALL SUPPORTS AND HANGERS FOR 2" PIPE. --------BLOWDOWN TANK

PROJECT

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DATE------09-02-11

NEWTON PUBLIC
SCHOOLS
BOWEN/COUNTRYSIDE
ELEMENTARY SCHOOL
BOILER RENOVATION
NEWTON, MA 02459

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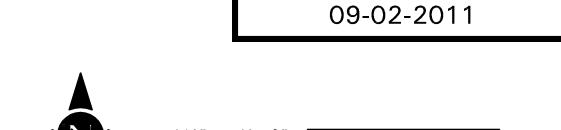
SCALE-

AS NOTED

MECHANICAL BOILER ROOM

NEW WORK PART PLAN





MECHANICAL - COUNTRYSIDE BOILER ROOM BREECHING

NEW WORK PART PLAN


SCALE: 1/4"=1'-0"

MECHANICAL - COUNTRYSIDE BOILER ROOM PIPING


NEW WORK PART PLAN


SCALE: 1/4"=1"-0"


M2.01

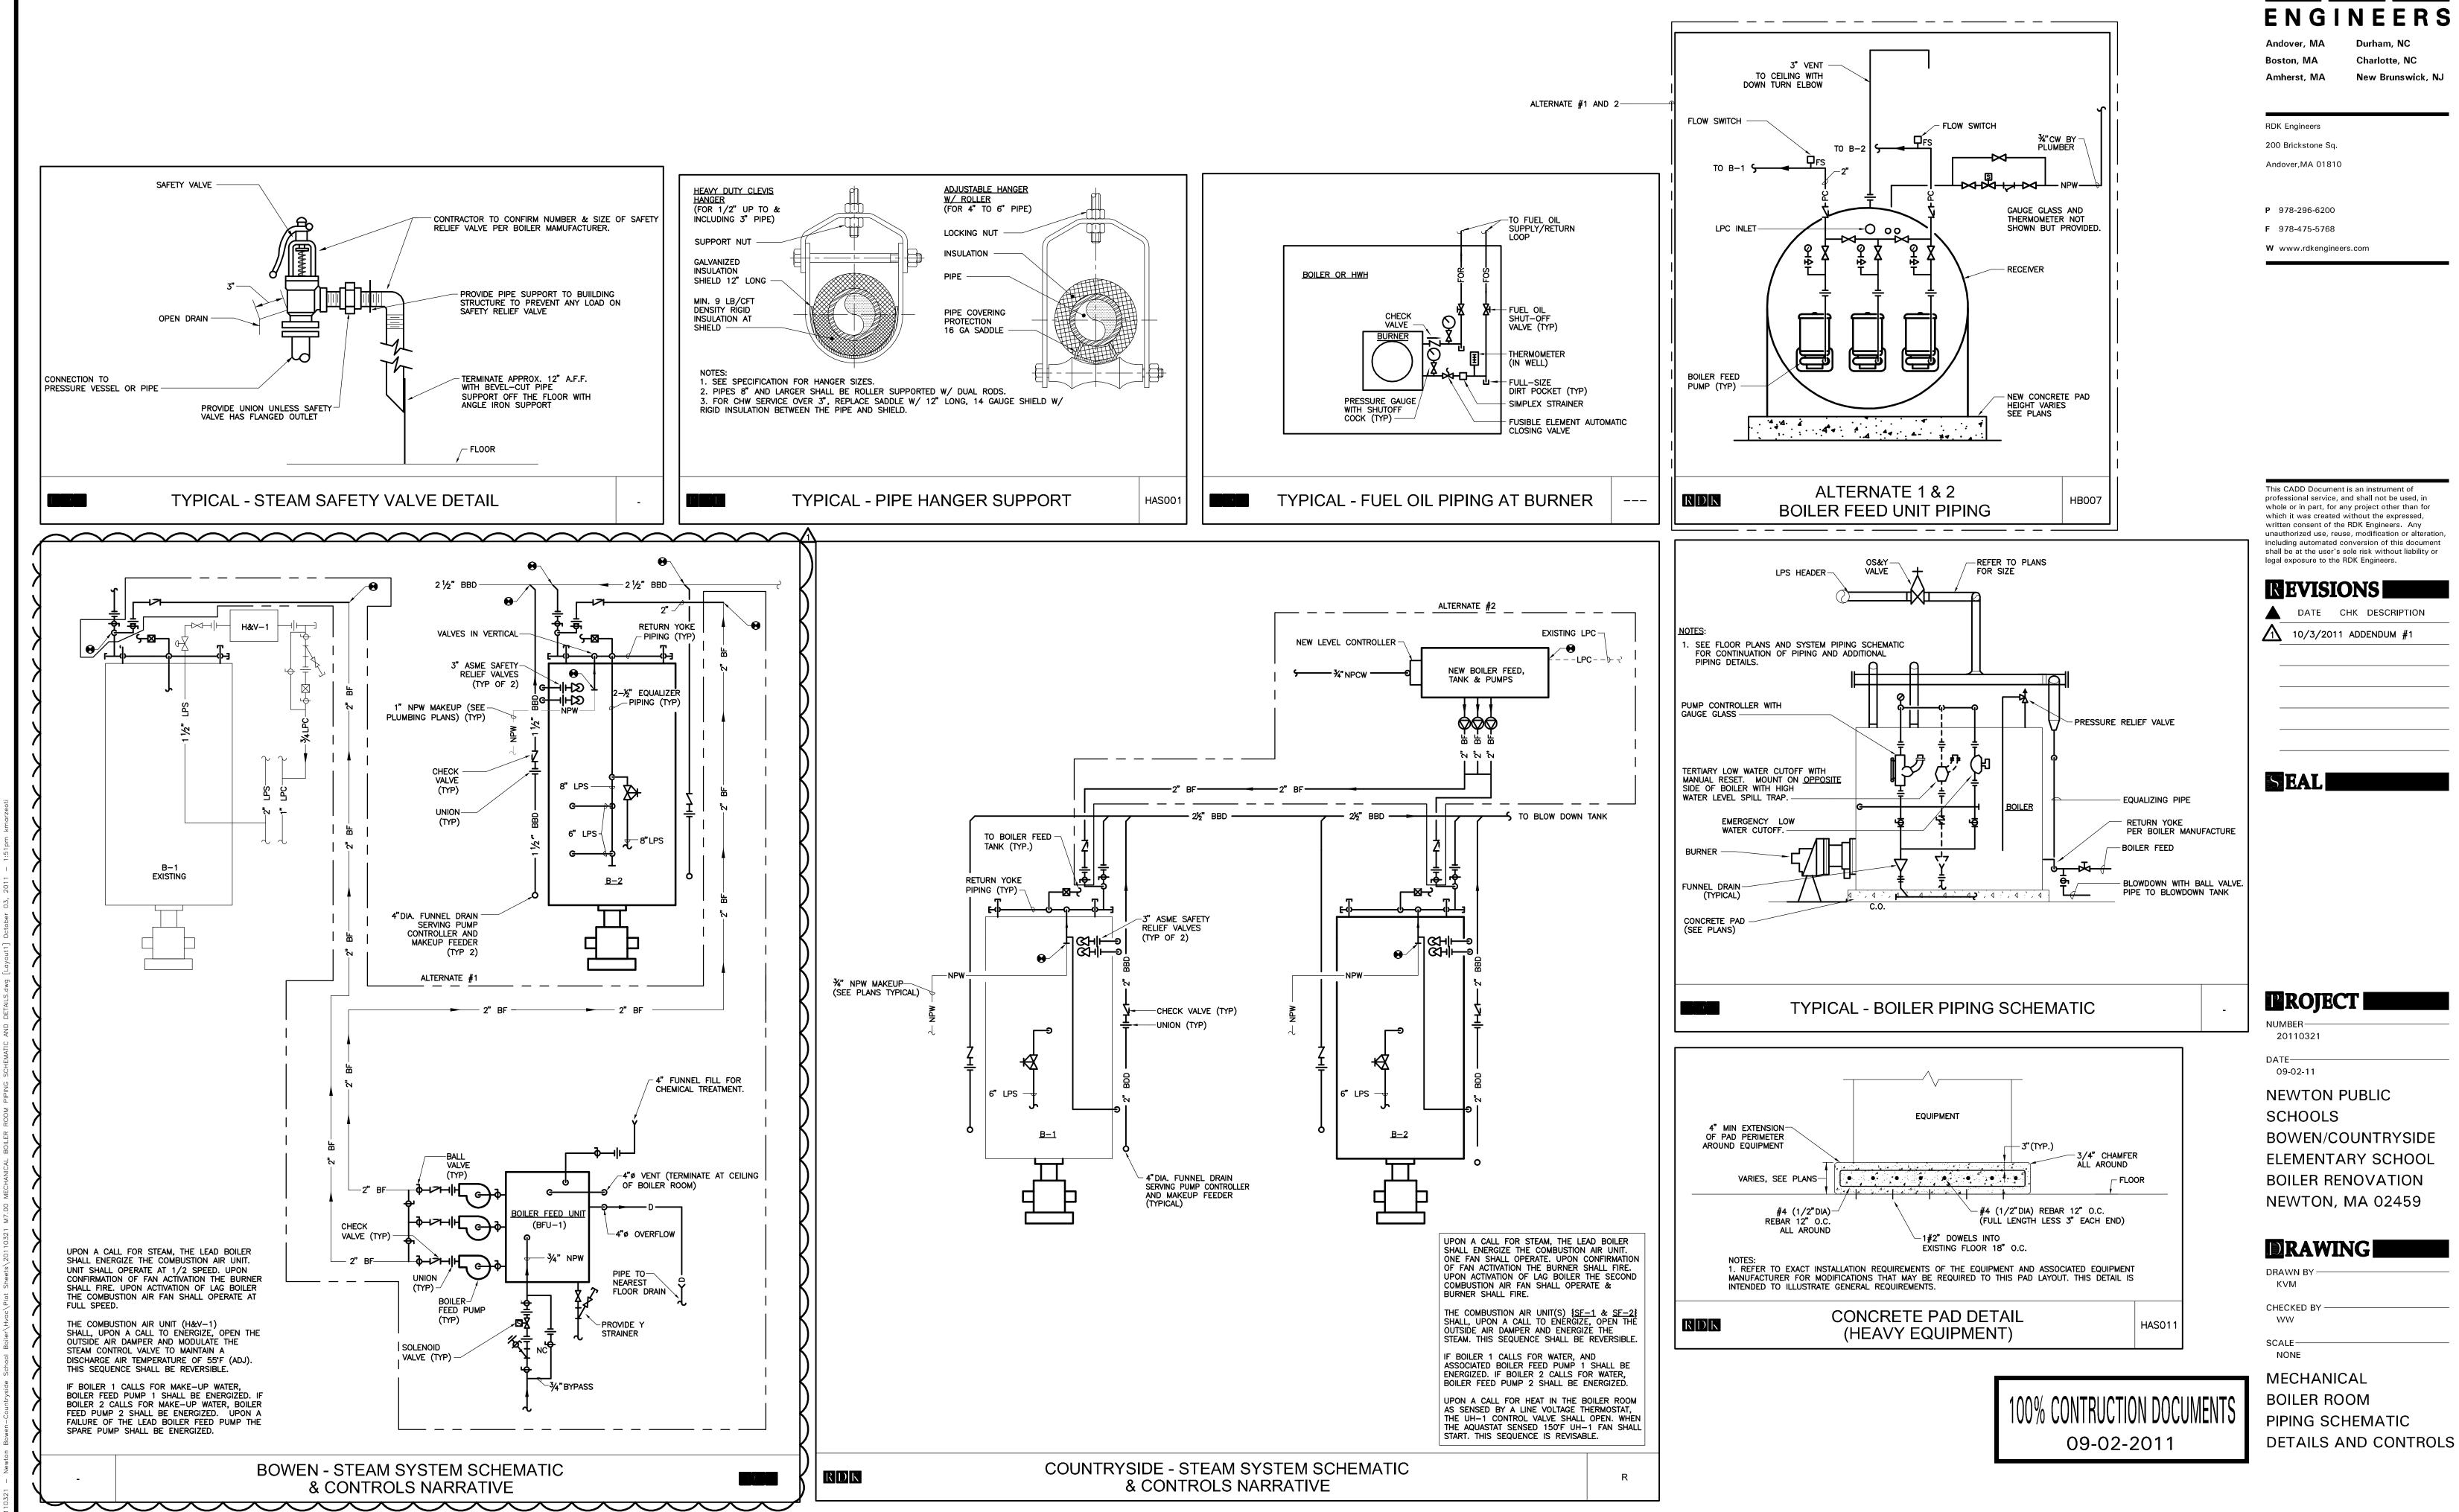



M7.00

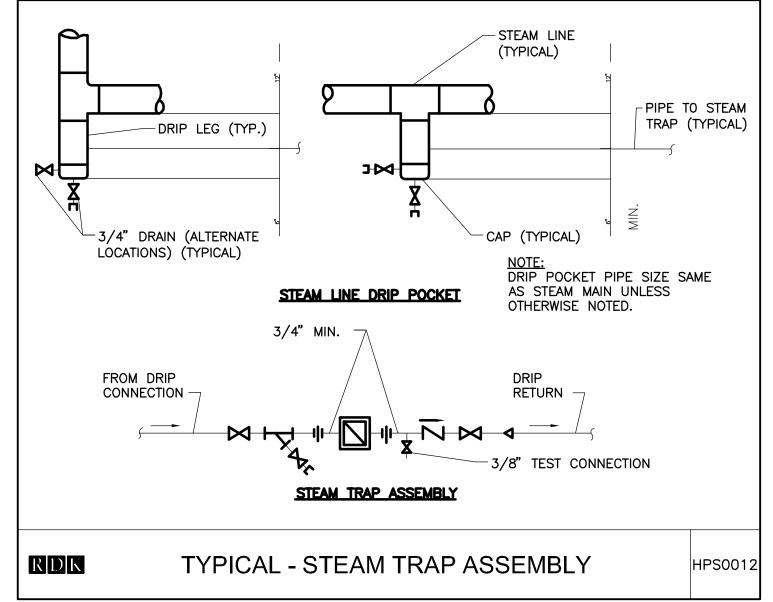


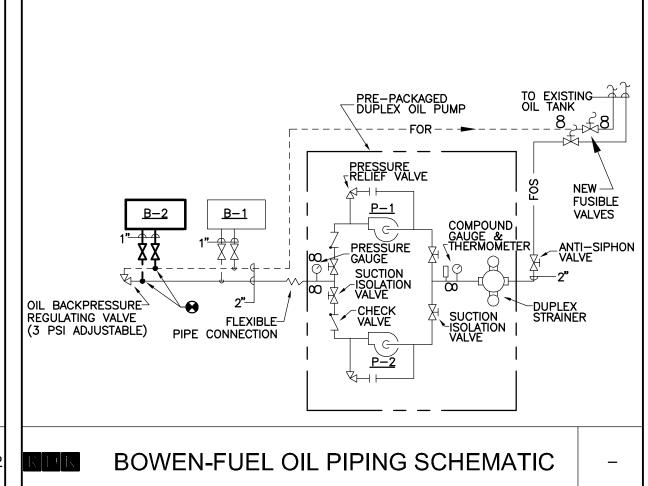


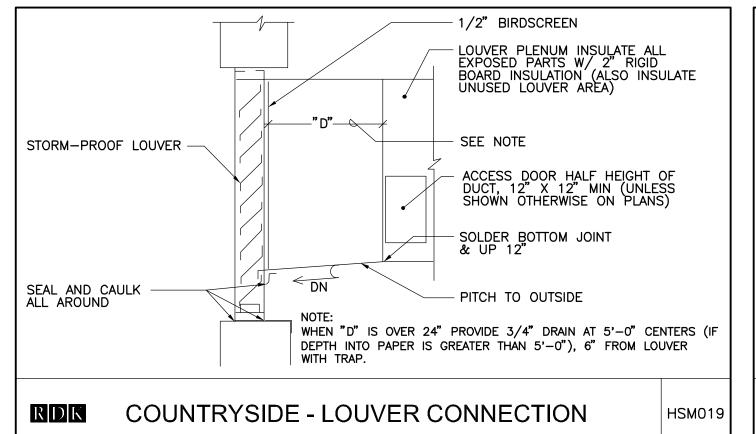


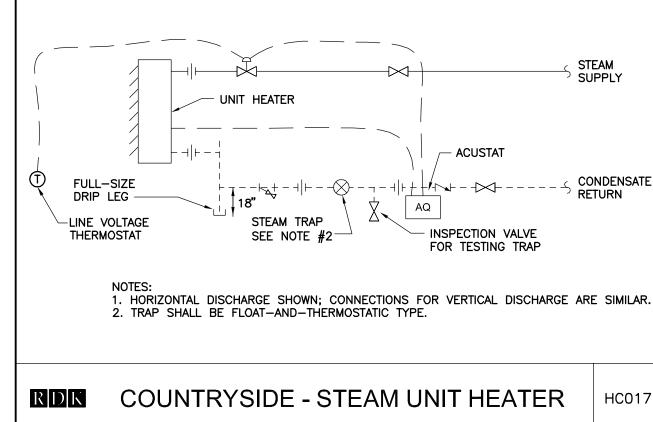


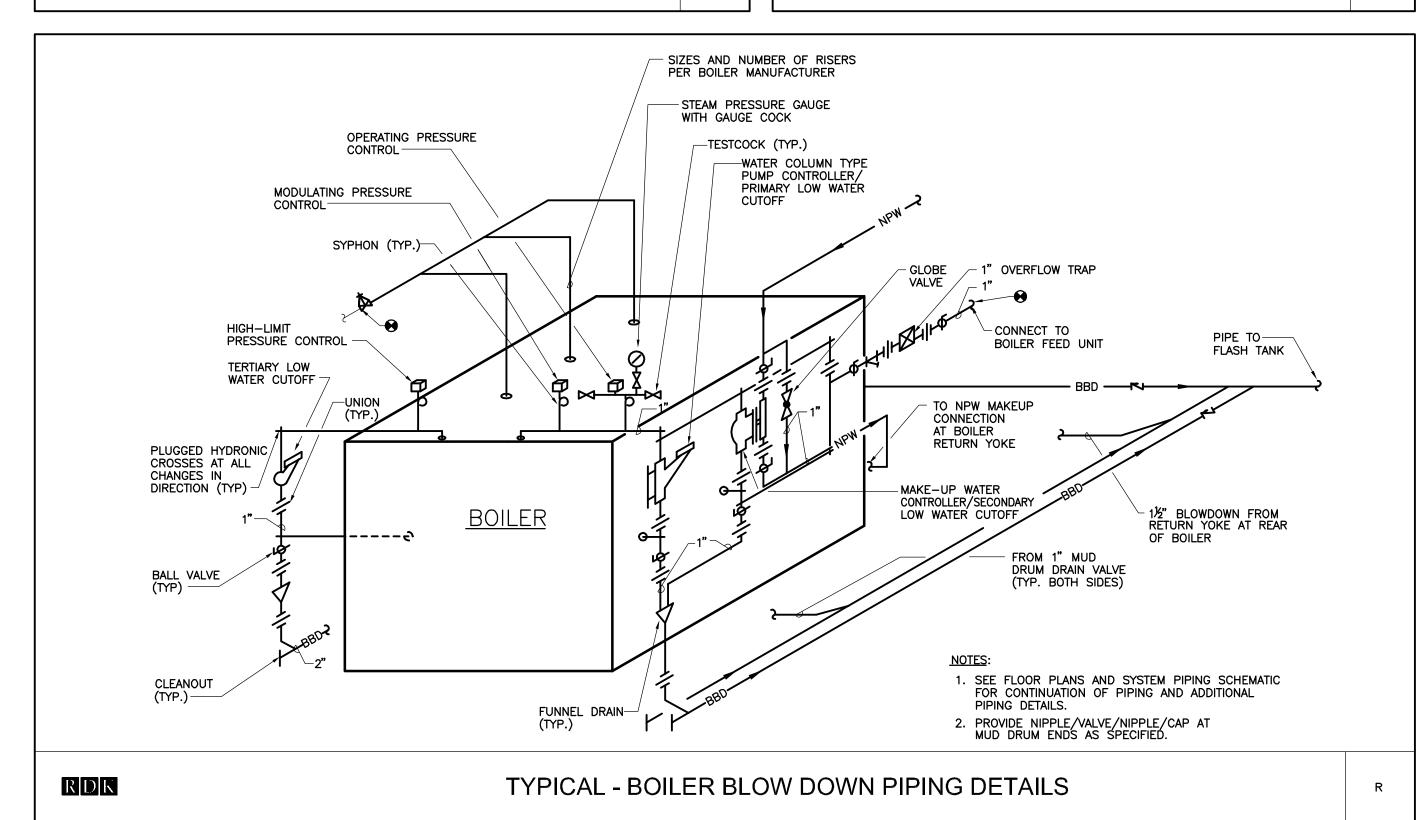


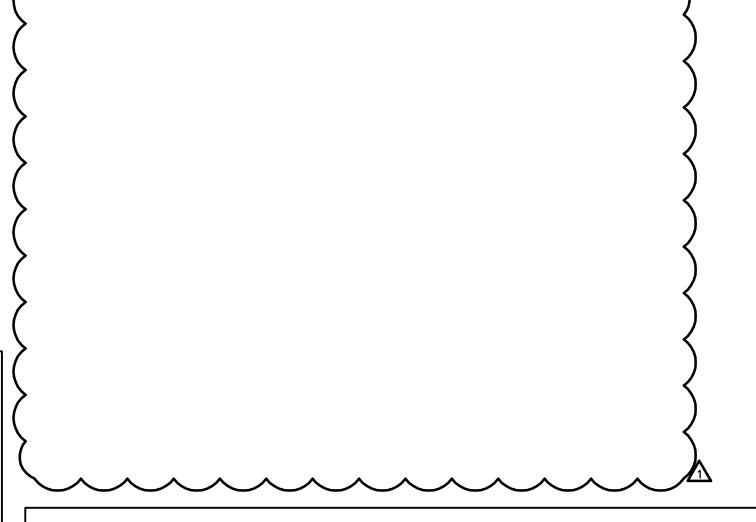

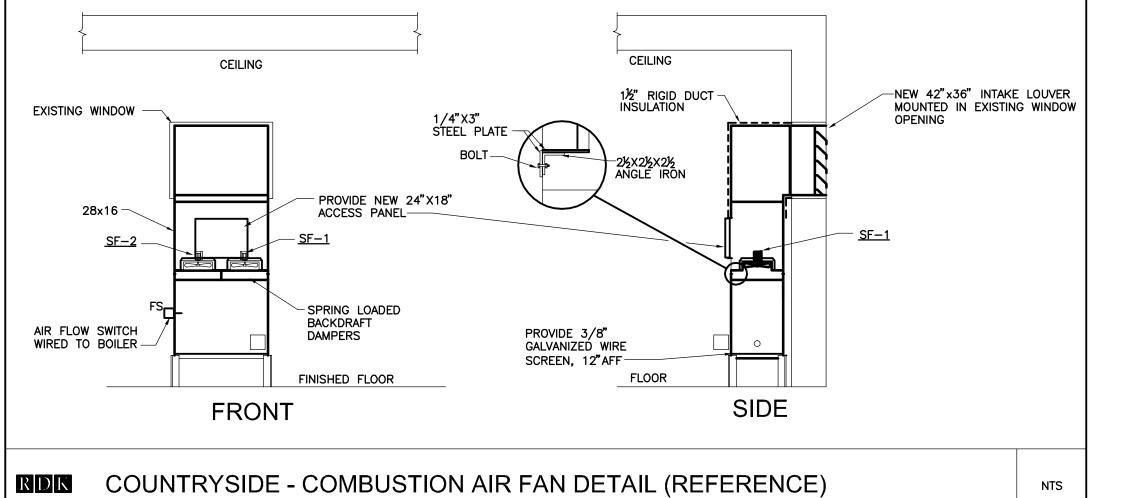

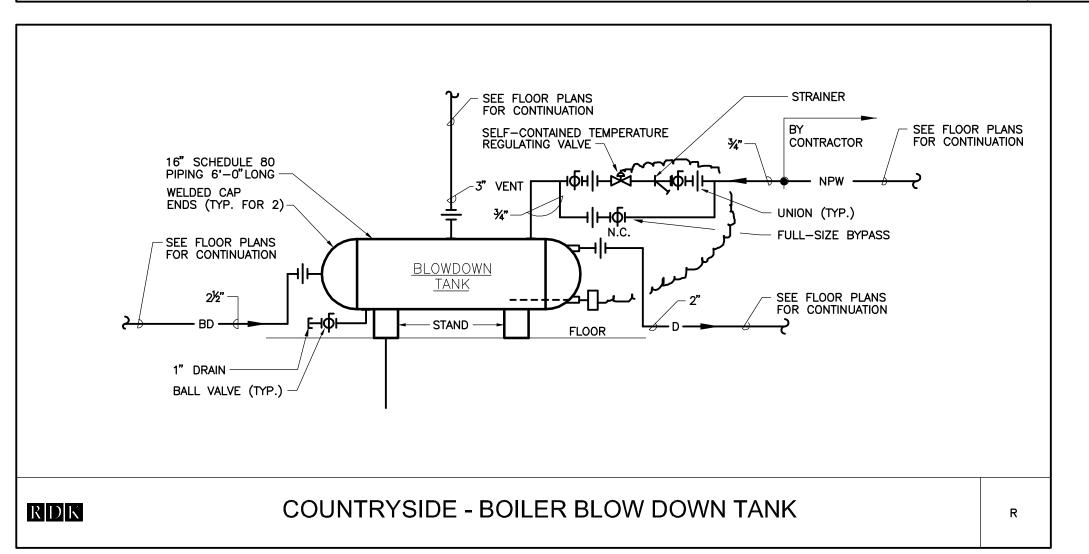

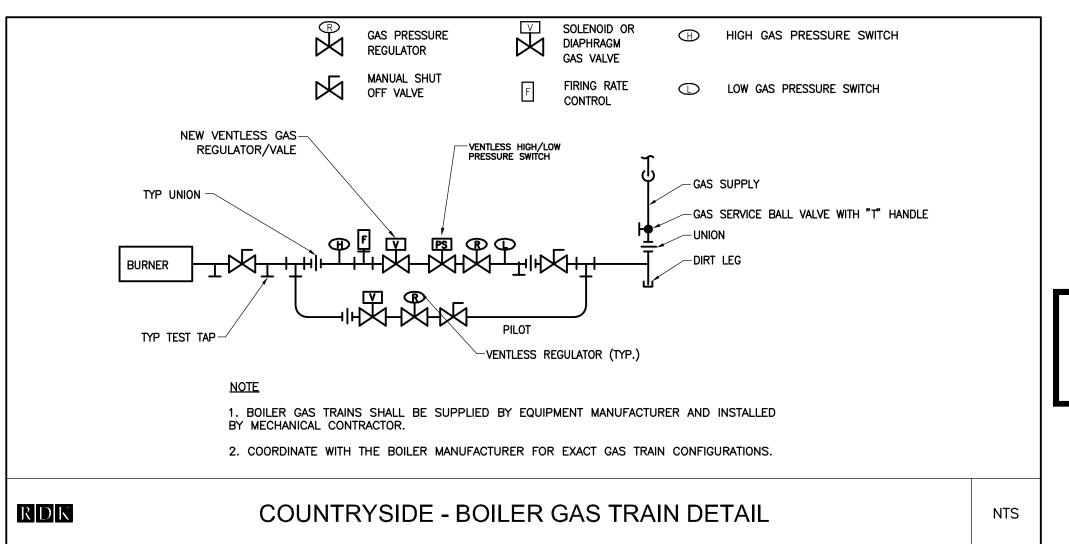

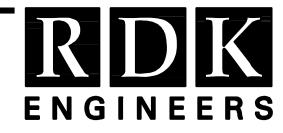

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10/3/2011 ADDENDUM #1

SEA

PROJECT

NUMBER —— 20110321

NEWTON PUBLIC
SCHOOLS
BOWEN/COUNTRYSIDE
ELEMENTARY SCHOOL
BOILER RENOVATION
NEWTON, MA 02459

DRAWING

DRAWN BY KVM

> CHECKED BY WW

SCALE----

NONE

ONTRUCTION DOCUMENTS

BOILER ROOM
PIPING SCHEMATIC
DETAILS AND CONTROLS

M7.01

\overline{R}	D	K
ENG	INE	ERS

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REMARKS

MANUFACTURER AND MODEL NUMBER

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10/3/2011 ADDENDUM #1

PROJECT

20110321

DATE---09-02-11

NEWTON PUBLIC SCHOOLS BOWEN/COUNTRYSIDE **ELEMENTARY SCHOOL BOILER RENOVATION** NEWTON, MA 02459

DRAWING

KVM

CHECKED BY

SCALE-NONE

MECHANICAL SCHEDULES

(G	LOCATION	I CALL	10111	SILAW	SILAW				LIVE220IVE											MANOTACTORER AND MODEL NOMBER	ILLIMAILIKS
		(GROSS	I=B=R)	(LB./HR)	PSIG			OIL	OIL	TYPE	TURN	-	BLOWER		CFM	TYPE	HP	VOLTS	PH	(AS STANDARD)	
		MBH	HP			°F	CFM	(GPH)	(PSIG)		MODEL	HP	V	PH							
-1	BOILER ROOM	3.853	115	4,313	15	-	2,400	38	25	OIL	I.C DL-54	3	208	3	2,400	AUBURN #16B75	1	208	3	H.B. SMITH - MILLS 4500A-S-12 SECTION	EXISTING
-2	BOILER ROOM	3.853	115	4,313	15	-	2,400	38	25	OIL	I.C DL-54	3	208	3	2,400	AUBURN #16B75	1	208	3	H.B. SMITH - MILLS 4500A-S-12 SECTION	NEW
0.7.5.0																					
OTES																					
PRO	OVIDE WITH MODU	LATING B	URNER																		
PRO	DVIDE WITH DRAFT	CONTRO	DL SYSTE	ΞM																	
PRO	OVIDE WITH REMO	TE CONTI	ROL PAN	IEL AND SI	NGLE POINT	T POWE	R CONNEC	CTION													

BOWEN - BOILER SCHEDULE (STEAM)

OUTPUT OUTPUT FIRING FUEL INLET
CAPACITY STEAM STEAM BREECHING RATE PRESSURE

			COU	NTRYSI	DE - AIR L	OUVER SO	CHEDULE	Ε	
DESIGNATION	AREA SERVED	MANUFACTURER & PART NO.	LOUVER DEPTH	EXISTING OPENING SIZE	MINIMUM FREE AREA	FREE AREA PROVIDED	MAXIMUM VELOCITY	MAXIMUM PRESSURE DROP (IN INCHES W.G.)	REMARKS
L-1	BOILER ROOM COMBUSTION AIR INTAKE	RUSKIN-ELF375X STATIONARY LOUVER	4"	42" X36"	_	-	500 FPM	0.07	PROVIDE W/ BAKED ENAMEL FINISH MATCH BUILDING COLOR; COORDINATE W/OWNER AND INSECT SCREEN

COUNTRYSIDE - UNIT HEATER SCHEDULE (STEAM)

COUNTRYSIDE - FAN SCHEDULE

TYPE (IN.WG) DIA. TYPE DRIVE VELOCITY RPM BHP HP V PH

(FPM)

950 | PROPELLER | 0.25 | 16" | PROP. | DIRECT | 293 | 1140 | 0.15 | 1/6 | 115 | 1 | COOK SWD - 16A11DA | 1 950 PROPELLER 0.25 | 16" PROP. DIRECT | 293 | 1140 | 0.15 | 1/6 | 115 | 1 | COOK SWD - 16A11DA | 2

WHEEL

AND MODEL NUMBER

(AS STANDARD)

RITTLING RH-86

MANUFACTURER

AND MODEL NUMBER

(AS STANDARD)

REMARKS

REMARKS

 OUTPUT
 AIR
 MOTOR

 TYPE
 MBH
 CFM
 EAT
 LAT
 RPM
 BHP
 HP
 ELECTRIC SERVICE

 (*F)
 (*F)
 (*F)
 HZ
 V
 PH

| STEAM | 86 | 500 | 60 | 115 | 1050 | - | 1/10 | 60 | 115 | 1

							С	TNUO	RYSIDE - E	OILE	R SCHE	DUL				
TAG	LOCATION	CAPA	PUT ACITY I=B=R)	OUTPUT STEAM (LB./HR)	STEAM PSIG	BREE	CHING	FIRING RATE	FUEL INLET PRESSURE GAS/OIL	TYPE	BURNER TURN		BLOWEF	2	MANUFACTURER AND MODEL NUMBER (AS STANDARD)	REMARKS
		MBH	HP	` , ,		°F	CFM	>	(IN.WG)/(PSIG)	\sim	MODEL	HP	V	PH	, ,	
B-1	BOILER ROOM	2232	67	2312	15	_	2,400		3.5	GÁS	POWERFLAME	1-1/2	208	3	H.B. SMITH - 28A-S-9	EXISTING TO REMA
B-2	BOILER ROOM	2232	67	2312	15	_	2,400		3.5	GAS	POWERFLAME	1-1/2	208	3	H.B. SMITH - 28A-S-9	NEW

NOTES: . PROVIDE WITH MODULATING BURNER

2. PROVIDE WITH SINGLE POINT POWER CONNECTION 3. GAS TRAIN SHALL BE SIZED FOR 4"W.C. GAS PRESSURE INLET

LOCATION

BOILER ROOM

TAG SERVICE LOCATION

. INTERLOCK WITH BOILER NO. 1

2. INTERLOCK WITH BOILER NO. 2

NOTES:

1. PROVIDE WITH LINE VOLTAGE THERMOSTAT, CONTROL VALVE, ACUASTAT


CFM

LOCATION	TAG		OUTPUT CAPACITY (GROSS 1=B=R)		FIRING RATE		FUEL INLET PRESSURE			BURNER				MANUFACTURER AND MODEL NUMBER	
LOCATION	TAG	LOCATION	МВН	HP	GAS (CFH)		GAS (IN.WG)		TYPE MAKE/MODEL	TURN DOWN	HP	BLOWEI V	R PH	(AS STANDARD)	REMARKS
BOILER ROOM	B-1	BOILER ROOM	3172	67	2836	• •	3.5		POWER FLAME C2-G0-2031	MODULATING	1-1/2	208	3	H.B. SMITH - 28A-S-9	NEW
BOILER ROOM	B-2	BOILER ROOM	3172	67	2836		3.5		POWER FLAME C2-G0-2031	MODULATING	1-1/2	208	3	H.B. SMITH - 28A-S-9	NEW

				BOW	EN -	– BC	DILEF	R FE	ED U	INIT S	SCHE	DULE	_ - -	
TAG NO.	LOCATION	MANUFACTURER	RECEIVER CAPACITY GALLONS			CONDEN	SATE PU	JMP DATA	1	ECTRICAL [DATA	NPSH	REMARKS	- ALTERNATE
		(AS STANDARD)	(EDR)	QTY	GPM	RPM	PSIG	HP	VOLTS	PHASE	HZ			」 !
BFU-1	MAIN BOILER ROOM	SKIDMORE MODEL VJSSM-153	110	3	17	3500	30.0	1	208	3	60	2.0	1. PROVIDE WITH UNIT MOUNTED CONTROL PANEL. 2. PROVIDE WITH MAKE-UP WATER ASSEMBLY.	
	= = = =			= = =		= = =		= = =		==	=	= =	_ = = = = = = = = = =	<u>-</u>]

			COL	JNTF	RYSID	E —	BOI	ILER	FEE	O UN	IT SC	CHEDI	ULE	
TAG NO.	LOCATION	MANUFACTURER (AS STANDARD)	RECEIVER CAPACITY GALLONS (EDR)	QTY	GPM	CONDEN RPM	SATE PL	JMP DATA MOTOR HP		ECTRICAL PHASE	DATA HZ	NPSH	REMARKS	
BFU-2	MAIN BOILER ROOM	SKIDMORE MODEL VJSSM-153	110	3	12	3500	30.0	1/2	208	3	60	2.0	1. PROVIDE WITH UNIT MOUNTED CONTROL PANEL. 2. PROVIDE WITH MAKE-UP ASSEMBLY	1

100% CONTRUCTION DOCUMENTS 09-02-2011

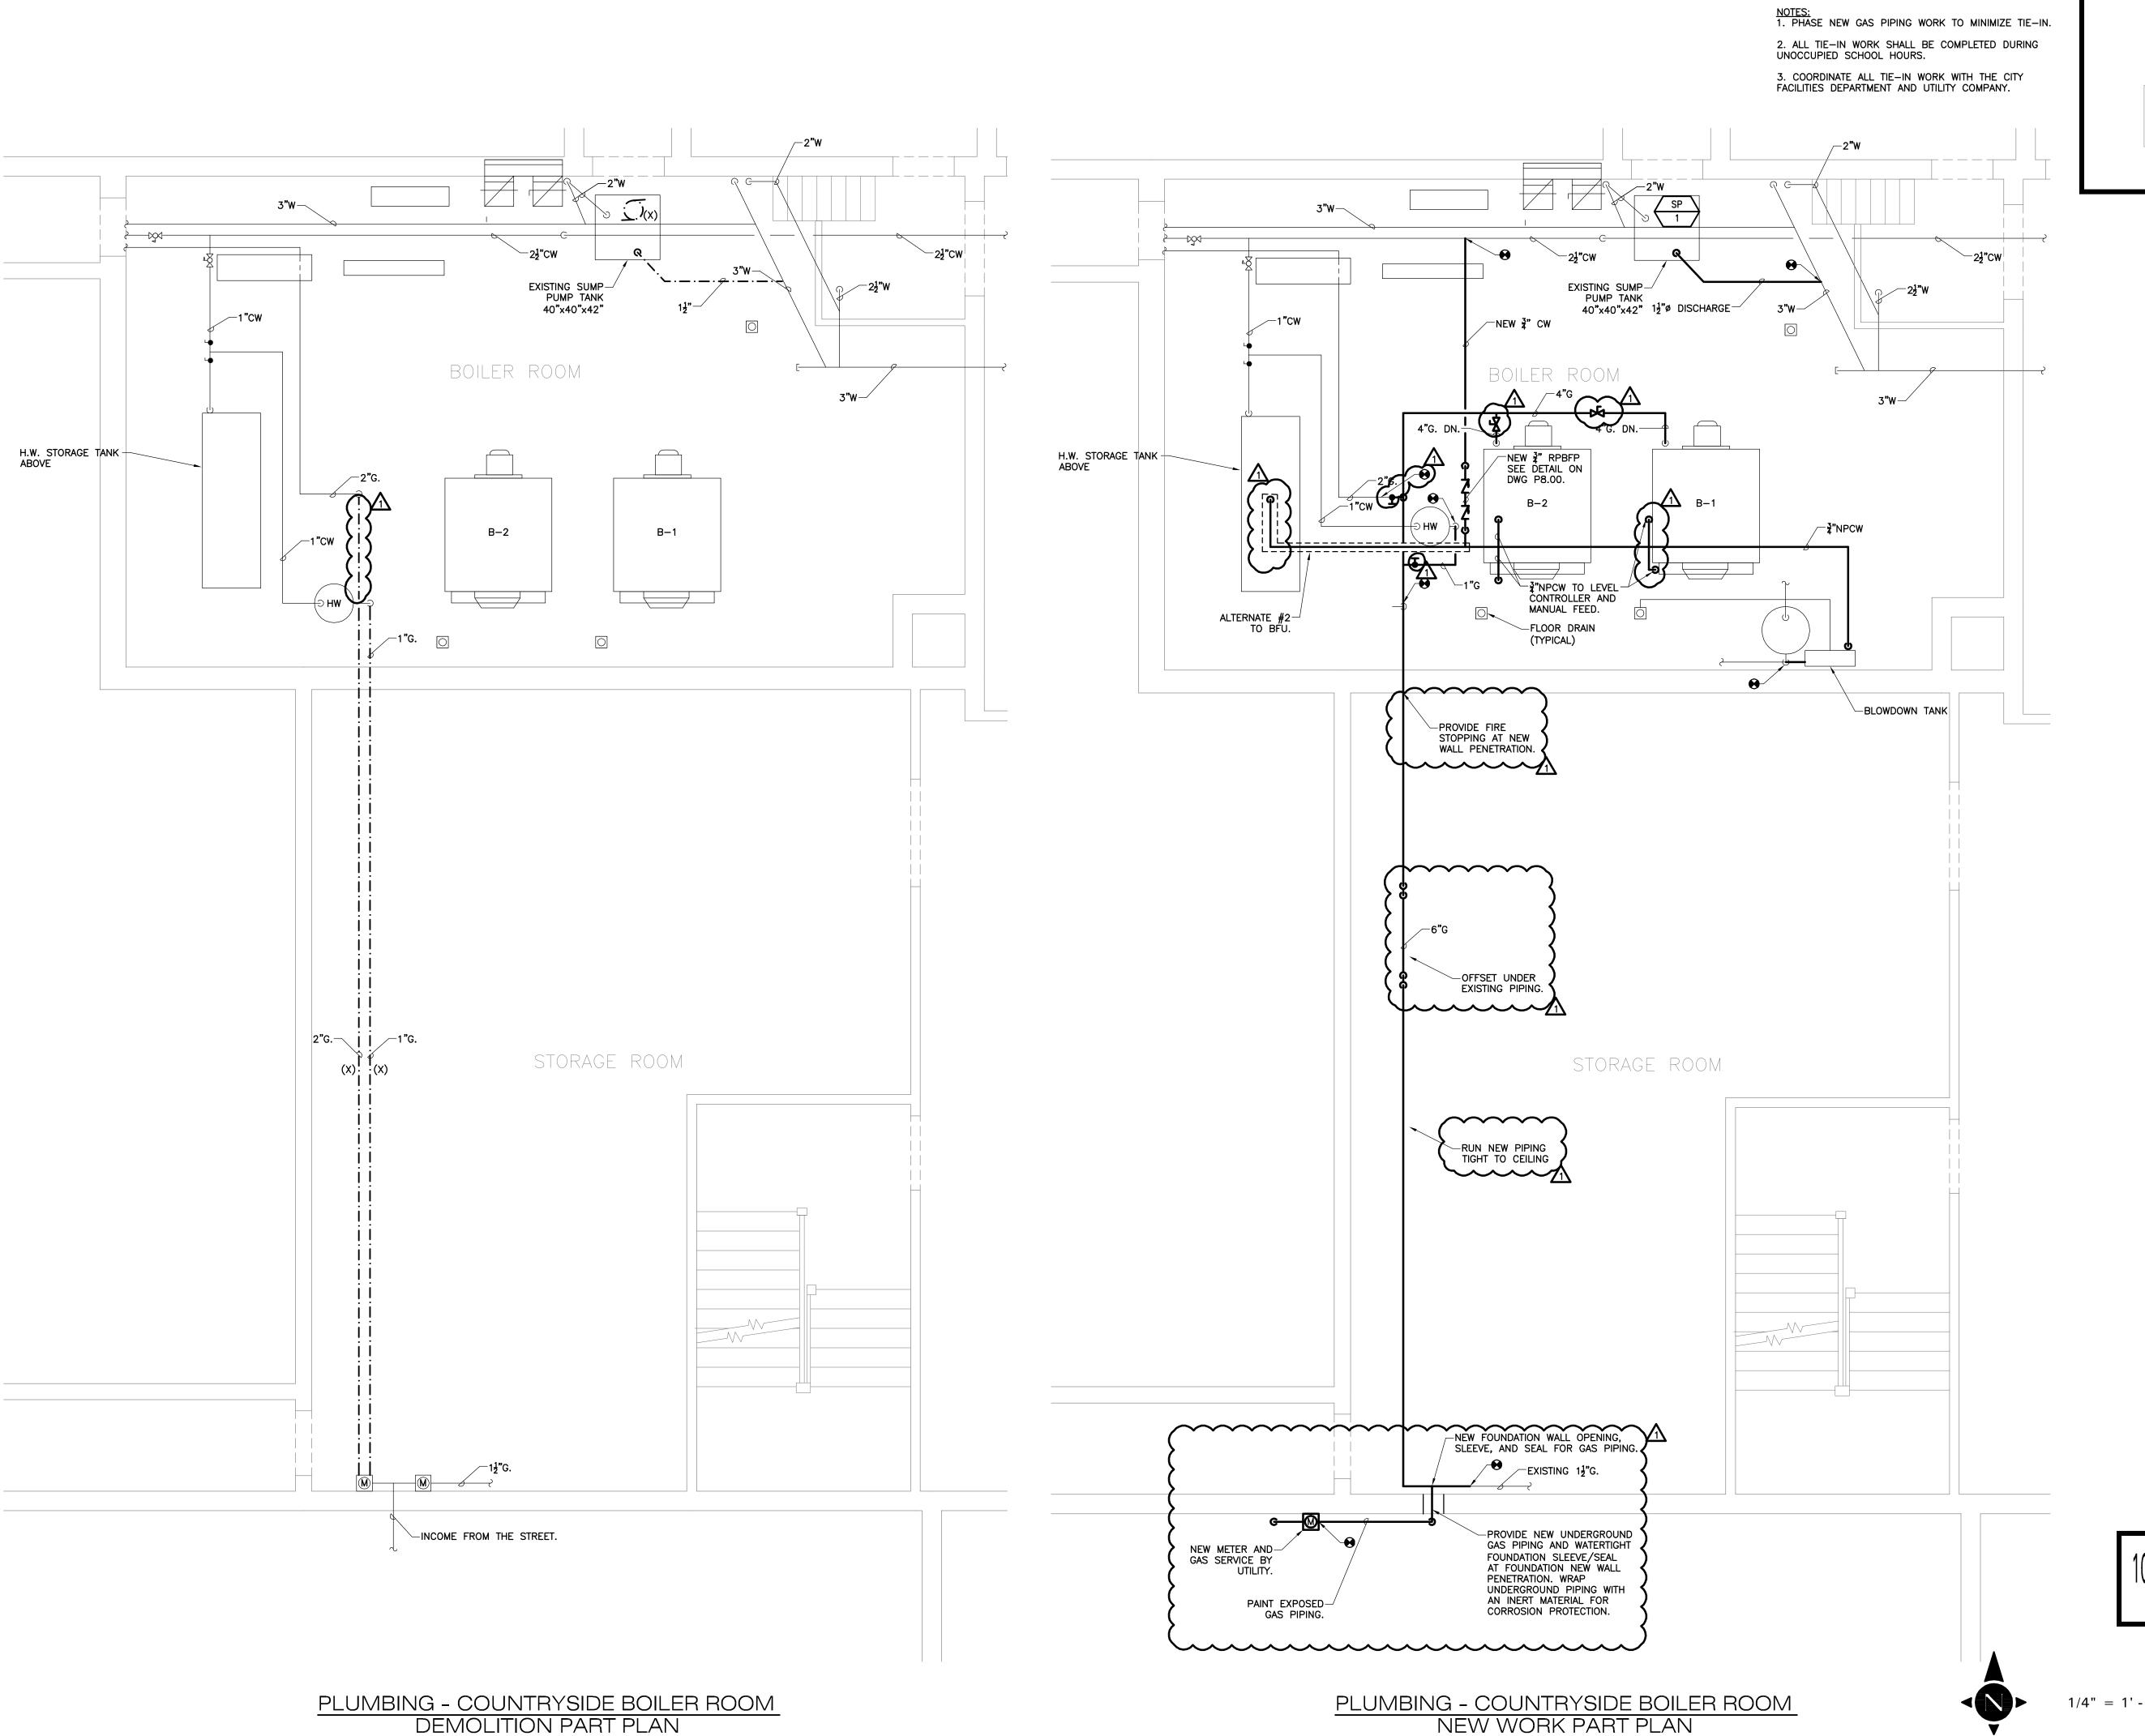

SCALE: 1/4"=1'-0"

New Brunswick, NJ

KEYPLAN

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PROJECT

20110321

09-02-11

NEWTON PUBLIC SCHOOLS BOWEN/COUNTRYSIDE **ELEMENTARY SCHOOL BOILER RENOVATION**

NEWTON, MA 02459

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WW

SCALE-

AS NOTED

PLUMBING **BOILER ROOM DEMOLITION AND NEW WORK** PART PLAN

09-02-2011